
CONDOMINIUM

800 N TAMIAMI TRAIL, SARASOTA, FL 34236



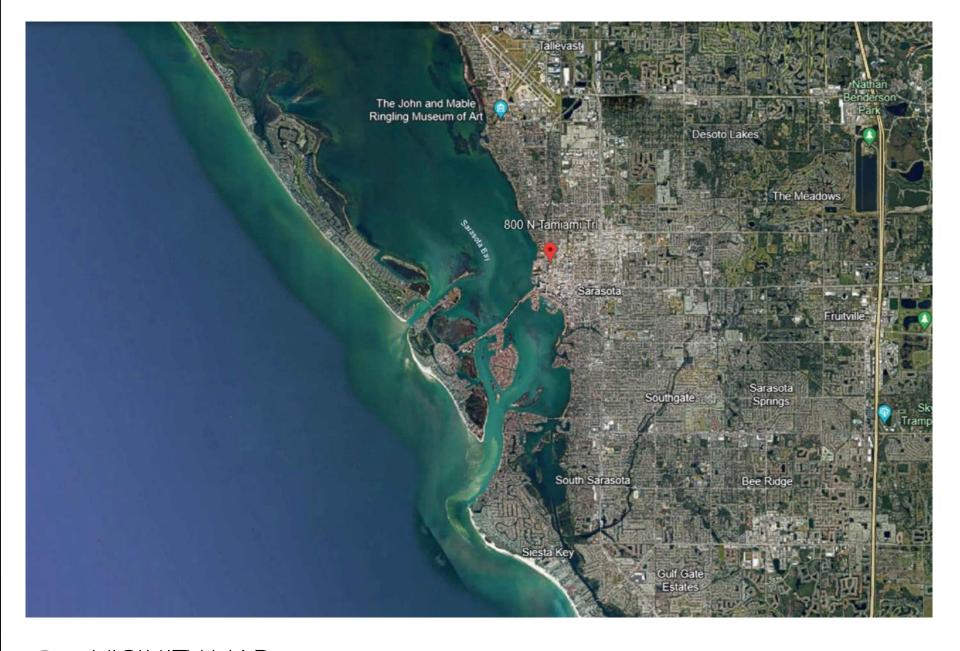

VICINITY MAP

ABBREVIATIONS


| AB | AIR BARRIER |
|-----------|----------------------|
| AD | AREA DRAIN |
| ADH | ADHESIVE |
| AHJ | AUTHORITY HAVING |
| | JURISDICTION |
| ALUM | ALUMINUM |
| ANC | ANCHOR, ANCHORED |
| ANOD | ANODIZED |
| APPROX | |
| ARCH | ARCHITECT, |
| / (rterr | ARCHITECTURAL |
| ASPH | ASPHALT, ASPHALTIC |
| ASSY | ASSEMBLY |
| BD | BOARD |
| BIT | BITUMEN, BITUMINOUS |
| BLDG | |
| BLKG | BLOCKING |
| BM | BEAM |
| BRKT | BRACKET |
| BTM | BOTTOM |
| BTW | BETWEEN |
| CEM | CEMENT, CEMENTITIOUS |
| CEN | CENTER |
| CFL | COUNTERFLASHING |
| CFMF | COLD FORMED METAL |
| CLIM | FRAMING |
| CL | CENTER LINE |
| CMU | CONCRETE MASONRY |
| CIVIO | UNIT |
| CNTR | COUNTER |
| COL | COLUMN |
| CONC | CONCRETE |
| COND | CONDITION |
| CPR | COPPER |
| DIA | DIAMETER |
| DIA | DIMENSION |
| DRN | DRAIN |
| DRN DS | DOWNSPOUT |
| DTL | DETAIL |
| EIFS | EXTERIOR INSULATION |
| LII S | AND FINISH SYSTEM |
| EJ | EXPANSION JOINT |
| EQ | EQUAL |
| EQUIP | EQUIPMENT |
| ETR | EXISTING TO REMAIN |
| EXP | EXPANSION |
| EXST | EXISTING |
| EXT | EXTERIOR |
| FD | FLOOR DRAIN |
| | FIREBLOCKING |
| FLSHG | FLASHING |
| FNDN | FOUNDATION |
| FP | FIREPROOFED, |
| I F | FIREPROOFING |
| FRJ | FIRE RESISTIVE JOINT |
| FRM | FRAME, FRAMED, |
| 1 1 1 1 1 | FRAMING |
| FRT | FIRE RETARDANT |
| | TREATED |
| FSTN | FASTENER |
| FT | FOOT, FEET |
| GALV | GALVANIZED |
| HDR | HEADER |
| HOR | |
| | HEIGHT |
| JST | JOIST |
| MECH | MECHANICAL |
| MEMB | MEMBRANE |
| MEP | MECHANICAL, |
| | ELECTRICAL, AND |
| | PLUMBING |
| MFR | MANUFACTURER, |
| 1.11.1.X | MANUFACTURED |
| MIFRC | MASTIC AND |
| | INTUMESCENT FIRE |
| | RESISTIVE COATING |
| MIN | MINIMUM |
| MIR | MIRROR |
| MISC | MISCELLANEOUS |
| MNRL | MINERAL |
| · · · · • | — |

| MOD | MODIFIED |
|----------|-------------------------|
| | MOUNTED |
| MTL | METAL |
| N | NORTH |
| - | NOT IN CONTRACT |
| | NUMBER |
| NSMF | NON-STRUCTURAL METAL |
| NOIVIE | FRAMING |
| | |
| NTS | NOT TO SCALE |
| OC | ON CENTER |
| OD | OUTSIDE DIAMETER, |
| | OVERFLOW DRAIN |
| ЭН | OPPOSITE HAND |
| OPCI | OWNER PROVIDED, |
| | CONTRACTOR INSTALLED |
| OPOI | OWNER PROVIDED, |
| | OWNER INSTALLED |
| PERF | PERFORATED |
| ΣĽ | PLATE |
| PLAS | PLASTER |
| PLBG | PLUMBING |
| | PLYWOOD |
| PT | PRESSURE TREATED |
| - PTD | PAINTED |
| QTR | QUARTER |
| 218 2 | RISER |
| RAD | |
| | RADIUS |
| | ROOF DRAIN |
| | REFER, REFERENCE |
| REINF | REINFORCED |
| REQD | |
| RESIL | RESILIENT |
| REV | REVISION |
| RFG | ROOFING |
| RO | ROUGH OPENING |
| SAB | SOUND ATTENUATION |
| | BLANKET |
| SBR | SEALANT & BACKER ROD |
| SCHED | SCHEDULE, SCHEDULED |
| SFRM | SPRAY APPLIED |
| | FIRE-RESISTIVE MATERIAL |
| SHT | SHEET |
| SLNT | SEALANT |
| SS | STAINLESS STEEL |
| STL | STEEL |
| | STRUCTURAL |
| | SYSTEM |
| SYS | |
| T&G | TONGUE AND GROOVE |
| THRU | HROUGH |
| TME | TO MATCH EXISTING |
| TOC | TOP OF CONCRETE |
| TOST | TOP OF STEEL |
| TWF | THROUGH WALL |
| | FLASHING |
| JIO | UNLESS INDICATED |
| | OTHERWISE |
| JL | UNDERWRITERS |
| | LABORATORIES |
| JNDRLAY | UNDERLAYMENT |
| JNF | UNFINISHED |
| VB | VAPOR BARRIER |
| VERT | VERTICAL |
| | VERIFY IN FIELD |
| | VENEER |
| | |
| | WITH |
| | WITHOUT |
| | WALL BOARD |
| WD | WOOD |
| WNDW | WINDOW |
| WP | WORKPOINT, |
| | WATERPROOFING |
| WS | WATERSTOP |
| WTW | WALL-TO-WALL |
| | WELDED WIRE FABRIC |
| | WELDED WIRE MESH |
| | |
| | |
| | |
| | |

FLORIDA PRODUCT APPROVALS

HENRY PUMADEQ - FL42468 HENRY PRODEQ - FL42469

CONDO ASSOCIATION

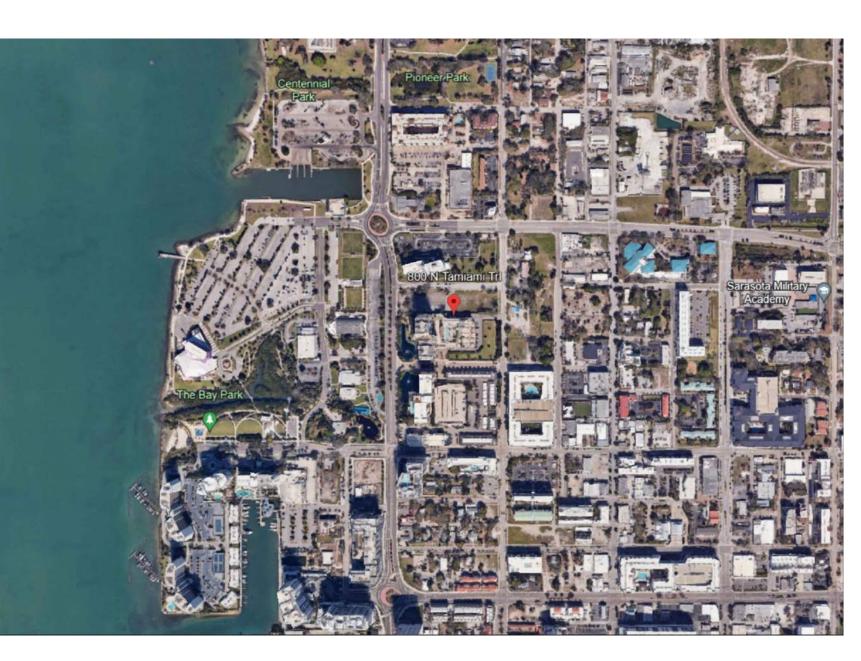

PROJECT SITE MAP

GENERAL NOTES


DRAWING INDEX G-0.01 S-1.01 COVER SHEET PLAN S-1.02 ENLARGED PLANS FRAMING PLANS & SECTIONS S-1.03 S-5.01 DETAILS S-5.02 DETAILS 520 12th st. W Suite 202 Bradenton, Florida 34205 ph: 941-212-0398 admin@dyneng.online dyneng.online CONTACT: MATTHEW MULLINS NOT FOR REGULATORY APPROVAL, PERMITTING, OR CONSTRUCTION MATERIALS CONCRETE WOOD BLOCK STEEL CONCRETE WALL BOARD PLASTER R-2 PLYWOOD CAVITY DRN 11 MATERIAL FING SYMBOLS ΖO ROOM NAME $\equiv 0$ **ROOM NAME & NUMBER** OFFICE Σž 001 **REVISION REFERENCE - SEE** 0 d REVISION SCHEDULE IN TITLEBLOCK OF THE SHEET $\Box \alpha$ /1\ 10/10/10 WHERE REFERENCE IS CONI INDICATED LEVEL 1 🔻 TOSL 100'-0" ELEVATION SYMBOL ♣ 100'-0" SPOT ELEVATION SYMBOL ELEVATION CHANGE SYMBOL "ו 🖵 EXTERIOR ELEVATION 1 \$1.01 REFERENCE BUILDING SECTION \\$5.01∕ REFERENCE PLEASE RECYCLE WALL SECTION REFERENCE \$5.01 1/S-5.01 DETAIL REFERENCE SPACING, AND CONNECTION TO EXISTING (SI.01) DETAIL REFERENCE MAP DRAWING TITLE - THE DRAWING NUMBER REFERS TO THE /ı∖ addenda #1 7/15/24 DRAWING, THE SCALE REFERS SCALE: N/A TO THE SCALE OF THE DATE PARTICULAR DRAWING ON THE SHEET ISSUED FOR INTERIOR ELEVATION REVIEW 4◀ S-1.01 ▶2 REFERENCE PHOTOGRAPH REFERENCE -7/7/24 X DATE INDICATES APPROXIMATE LOCATION AND DIRECTION $\langle \gamma \rangle$ PROJECT NUMBERS OF REFERENCED PHOTOGRAPH DOOR REFERENCE 4.24-0010 DYNE: / 100 KEY NOTE REFERENCE - SEE KEY NOTES ON THE SHEET (1)COVER WHERE REFERENCE IS INDICATED SHEET A.1 EXISTING COLUMN GRID TAG (A.1) G0.01 NEW COLUMN GRID TAG [–] TRUE NORTH PLAN NORTH

- 2023 FBC BUILDING, 8TH ED.


WORK SHALL BE INSTALLED IN ACCORDANCE WITH THE APPROVED CONSTRUCTION

OCCUPANCY:

SECURE AND PAY FOR ALL PERMITS AND GOVERNMENTAL FEES, LICENSES AND INSPECTIONS NECESSARY FOR THE PROPER EXECUTION AND COMPLETION OF THE WORK. VERIFY ALL DIMENSIONS, EXISTING CONDITIONS, AND QUANTITIES PRIOR TO BEGINNING WORK. NOTIFY THE ENGINEER IMMEDIATELY UPON DISCOVERY OF ANY UNFORESEEN CONDITIONS. DO NOT SCALE DRAWINGS. OBTAIN OWNER APPROVAL FOR ALL COLORS AND FINISHES. CODES AND STANDARDS ALL WORK MUST BE PERFORMED IN ACCORDANCE WITH: • 2023 FBC - EXISTING BUILDING, 8TH ED. • 2023 FBC - PLUMBING, 8TH ED. ASCE/SEI 7-22 NRCA WATERPROOFING MANUAL SMACNA ARCHITECTURAL SHEET METAL MANUAL MANUFACTURER'S INSTALLATION INSTRUCTIONS APPLICABLE FLORIDA PRODUCT APPROVALS INDUSTRY STANDARDS, GUIDES AND BEST PRACTICES • FEDERAL, STATE AND LOCAL LAWS, RULES AND REGULATIONS AMENDED CONSTRUCTION DOCUMENTS DOCUMENTS, AND ANY CHANGES MADE DURING CONSTRUCTION THAT ARE NOT IN COMPLIANCE WITH THE APPROVED CONSTRUCTION DOCUMENTS SHALL BE RESUBMITTED FOR APPROVAL AS AN AMENDED SET OF CONSTRUCTION DOCUMENTS. BUILDING DATA CONSTRUCTION TYPE: MEANS OF EGRESS NO CHANGE IN MEANS OF EGRESS DEFERRED SUBMITTALS DEFERRAL OF ANY SUBMITTAL ITEMS SHALL HAVE THE PRIOR APPROVAL OF THE BUILDING OFFICIAL. THE REGISTERED DESIGN PROFESSIONAL IN RESPONSIBLE CHARGE SHALL LIST THE DEFERRED SUBMITTALS ON THE CONSTRUCTION DOCUMENTS FOR REVIEW BY THE BUILDING OFFICIAL. DOCUMENTS FOR DEFERRED SUBMITTAL ITEMS SHALL BE SUBMITTED TO THE REGISTERED DESIGN PROFESSIONAL IN RESPONSIBLE CHARGE WHO SHALL REVIEW THEM AND FORWARD THEM TO THE BUILDING OFFICIAL WITH A NOTATION INDICATING THAT THE DEFERRED SUBMITTAL DOCUMENTS HAVE BEEN REVIEWED AND FOUND TO BE IN GENERAL CONFORMANCE TO THE DESIGN OF THE BUILDING. THE DEFERRED SUBMITTAL ITEMS SHALL NOT BE INSTALLED UNTIL THE DEFERRED SUBMITTAL DOCUMENTS HAVE BEEN APPROVED BY THE BUILDING OFFICIAL. LIST OF DEFERRED SUBMTTALS: • PLUMBING PLAN - SHOW DRAIN LOCATION, DRAIN LEADER SIZE AND SLOPE, HANGER ENGINEER'S STATEMENT TO THE BEST OF THE ENGINEER'S KNOWLEDGE, JUDGMENT AND BELIEF, THESE DRAWINGS WERE PREPARED TO COMPLY WITH THE REQUIREMENTS OF THE FOLLOWING STANDARDS AND CODES: 2023 FBC - BUILDING, 8TH ED. 2023 FBC - EXISTING BUILDING, 8TH ED. 2023 FBC - PLUMBING, 8TH ED. THESE DRAWINGS ARE NOT VALID: IF A NEW VERSION OF THE CODE IS ADOPTED BY THE AHJ PRIOR TO PERMITTING; AFTER ONE YEAR; UNLESS SIGNED BY A LICENSED PROFESSIONAL ENGINEER. THESE DRAWINGS SHALL BE VIEWED ON ARCH D (24 X 36) SHEETS. OTHER SHEETS ARE NOT VALID. © DYNAMIC ENGINEERING DESIGN & INSPECTION

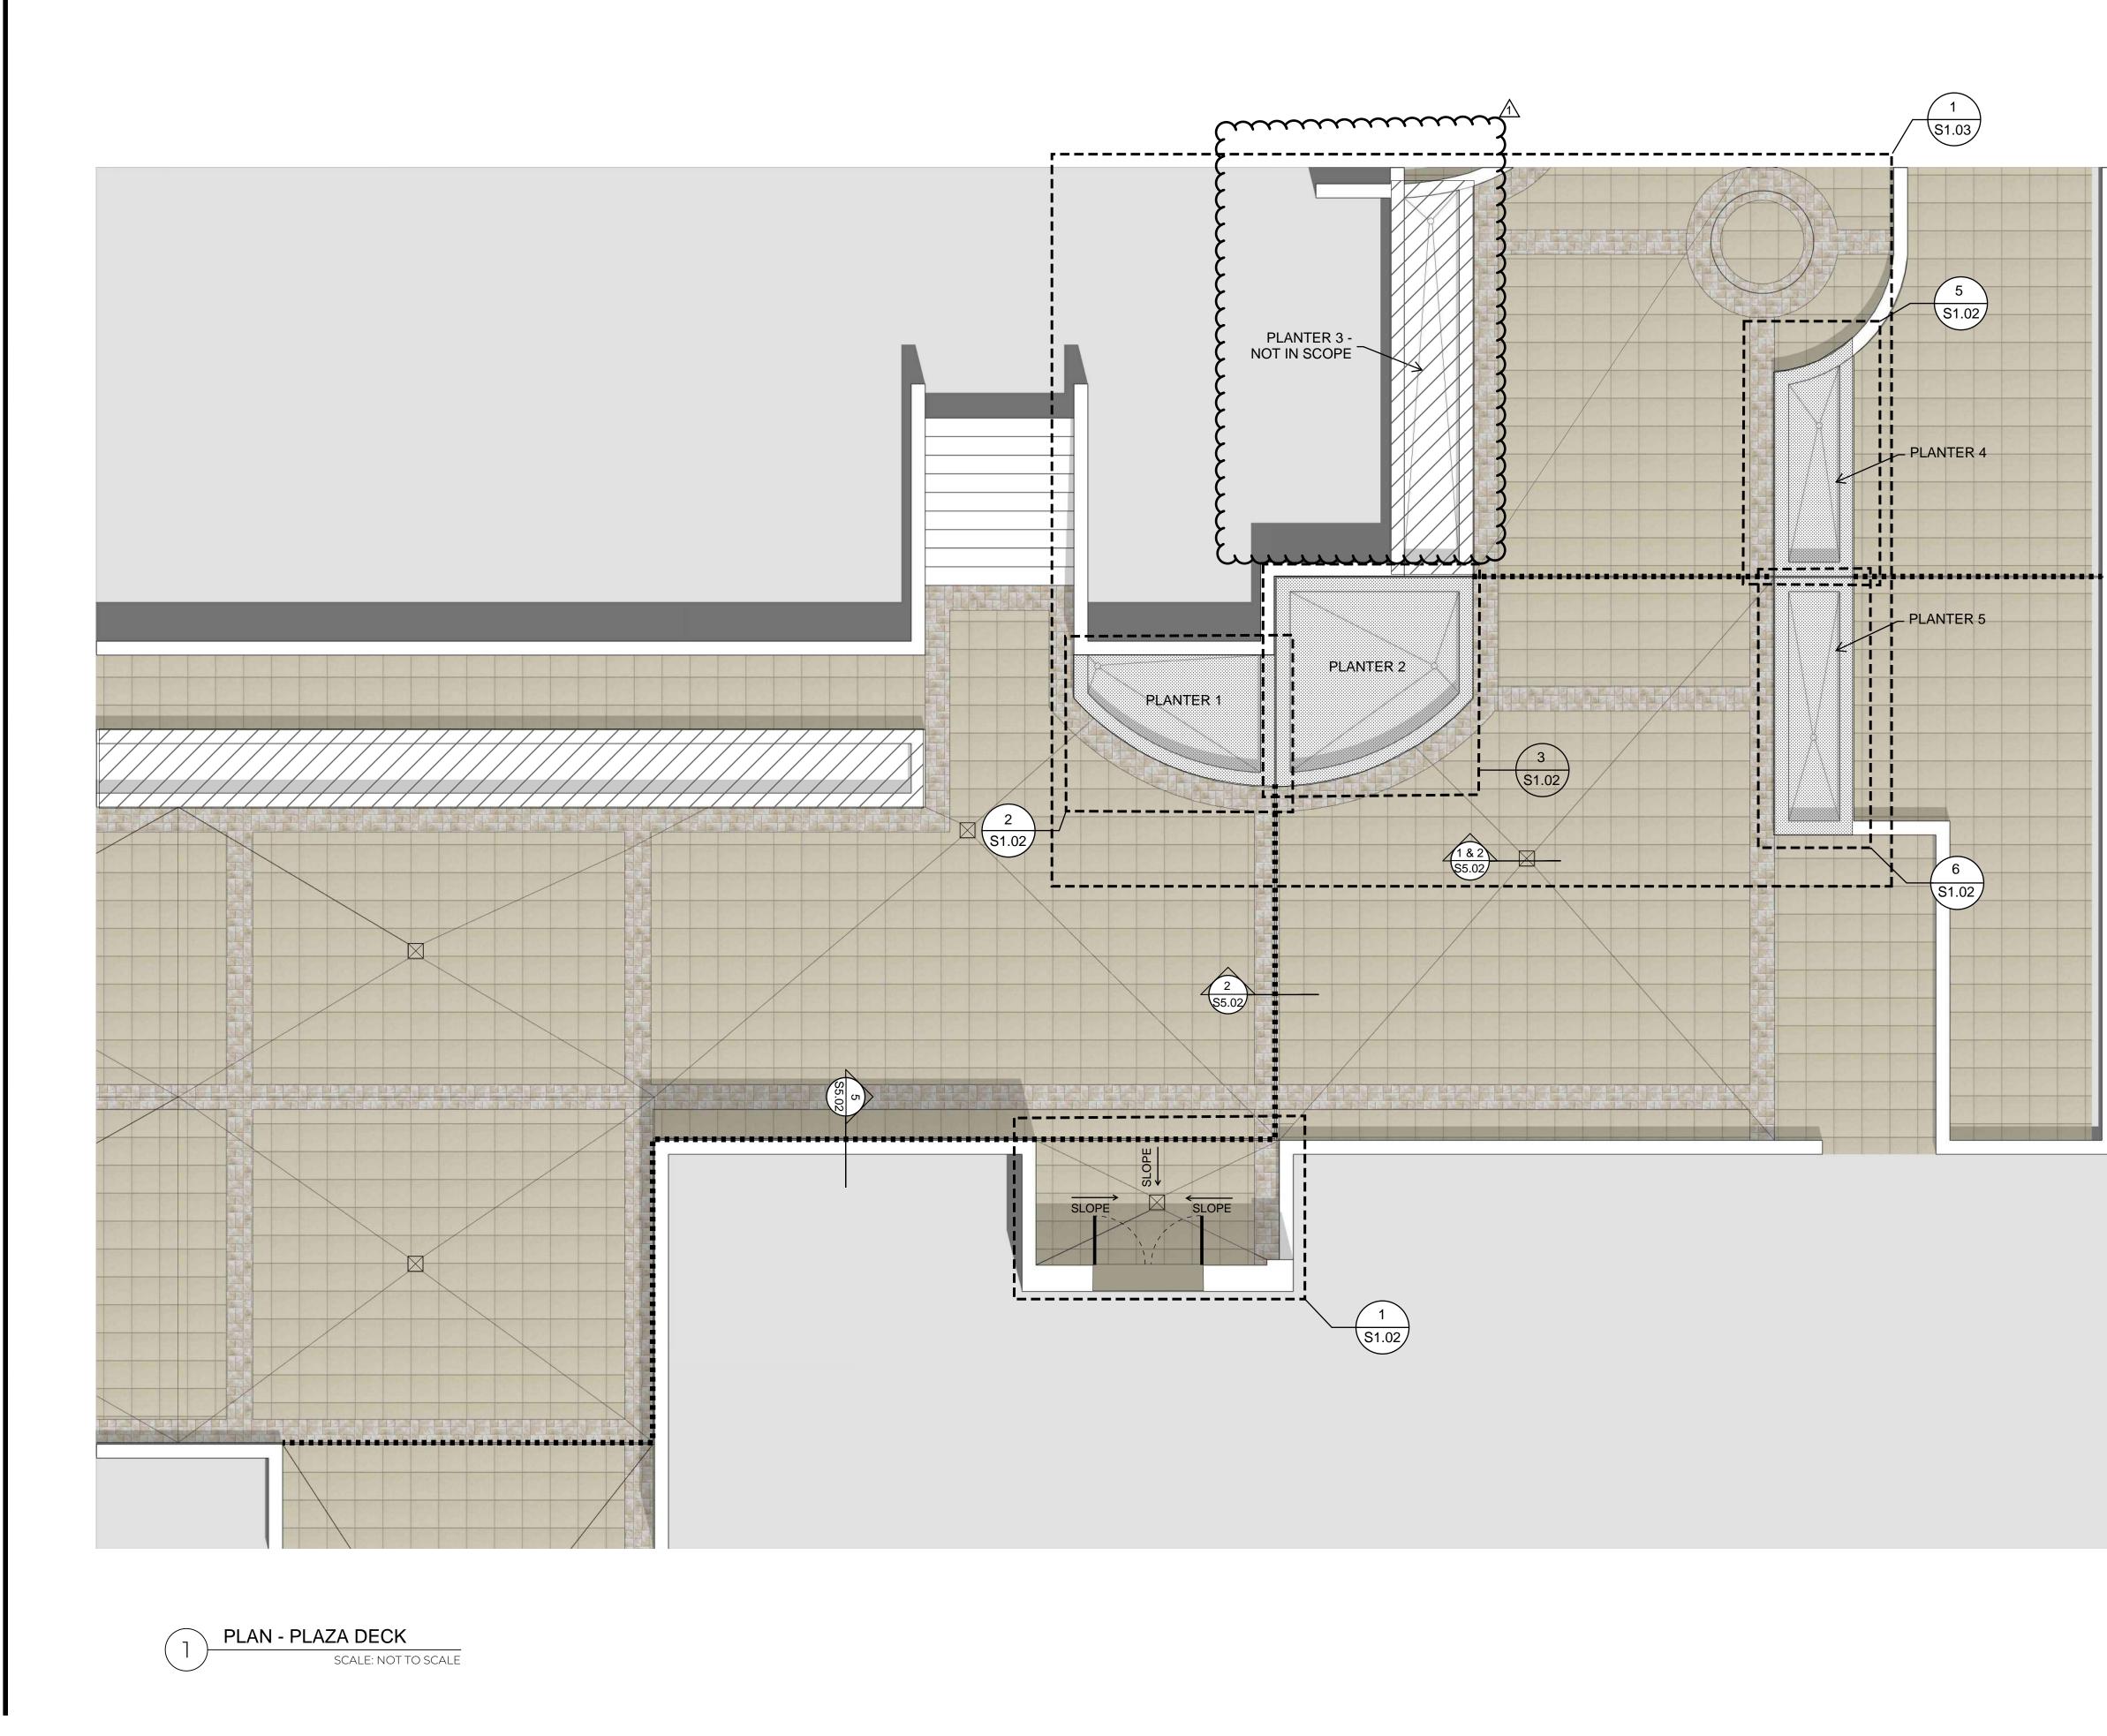


MIC ENGINEERING 2023 E:\07 FREELANCE WORK\ALINARI\ALINARI\ALINARI WATERPROOFING.DWG 6/14/2024 6:42:33

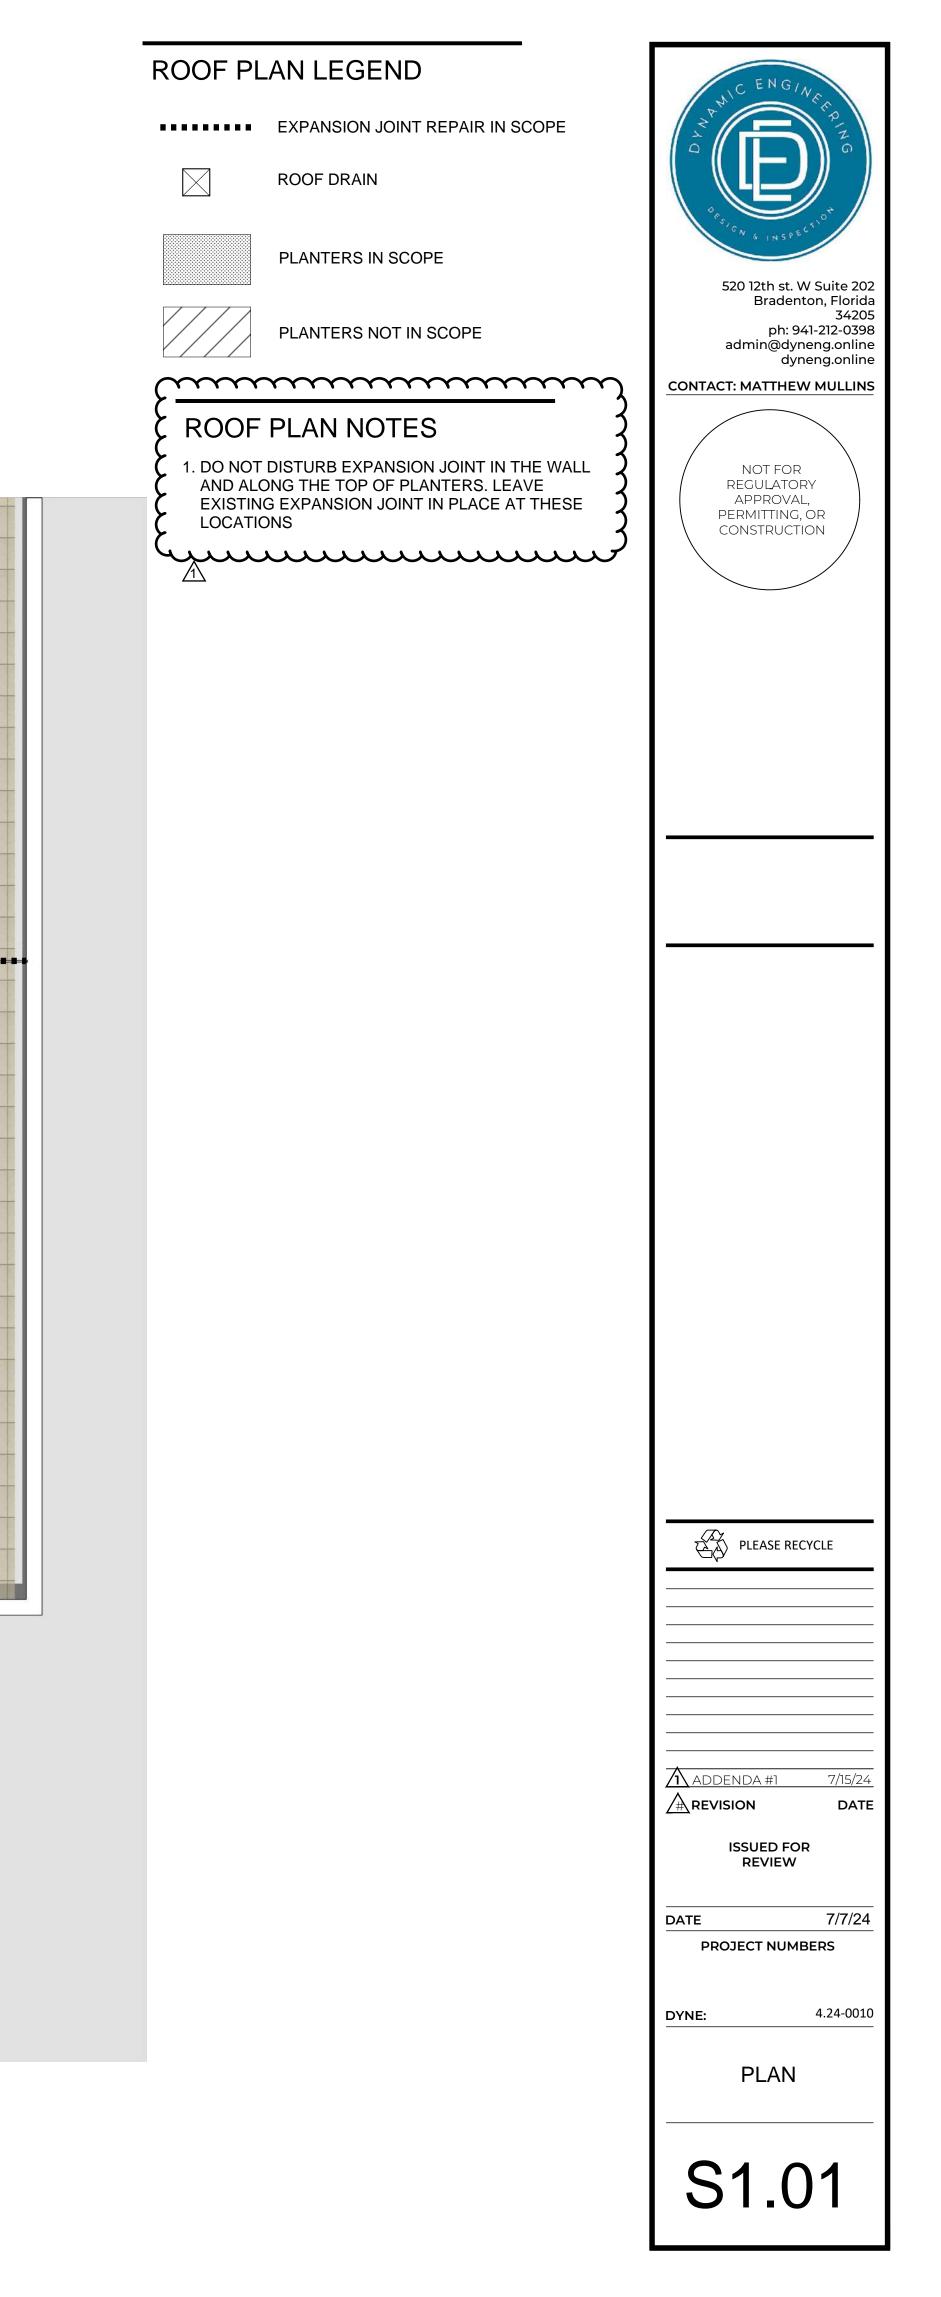


PROVIDE NEW DRAIN BOARD, TOPPING - SLAB AND BEDDING SAND BEFORE REINSTALLING EXISTING PAVERS


REMOVE ALL EXISTING MATERIAL, INSTALL NEW HENRY PUMADEQ FLEX SL WATERPROOFING OVER EXISTING - RUBBERIZED ASPHALT WATERPROOFING. INSTALL NEW DRAIN & DRAIN COMPONENTS TO MATCH EXISTING. REF 4/S5.02 FOR NEW ASSEMBLY

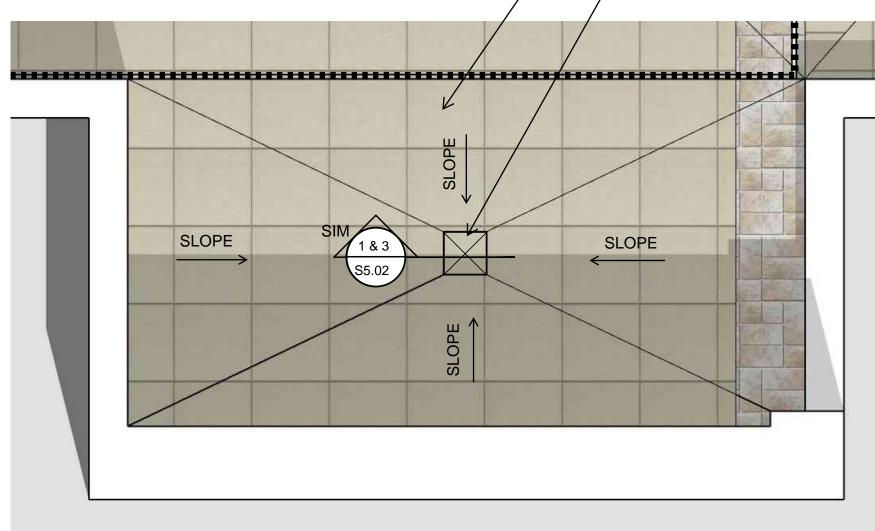


ENLARGED PLAN - NEW PLAZA DECK DRAIN 1 SCALE: NOT TO SCALE


FL 3436

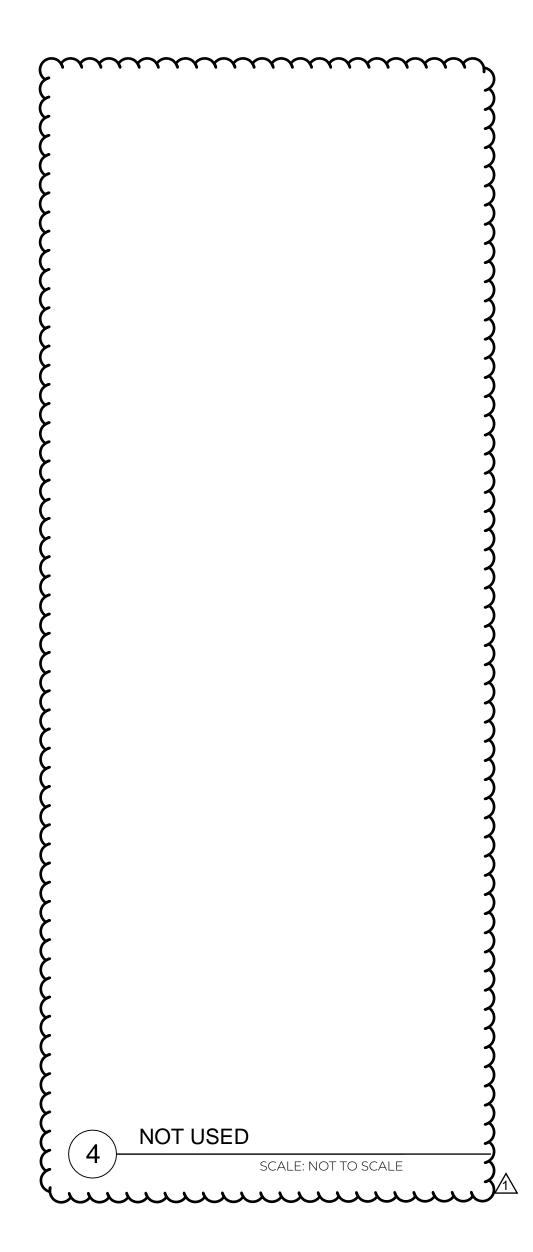

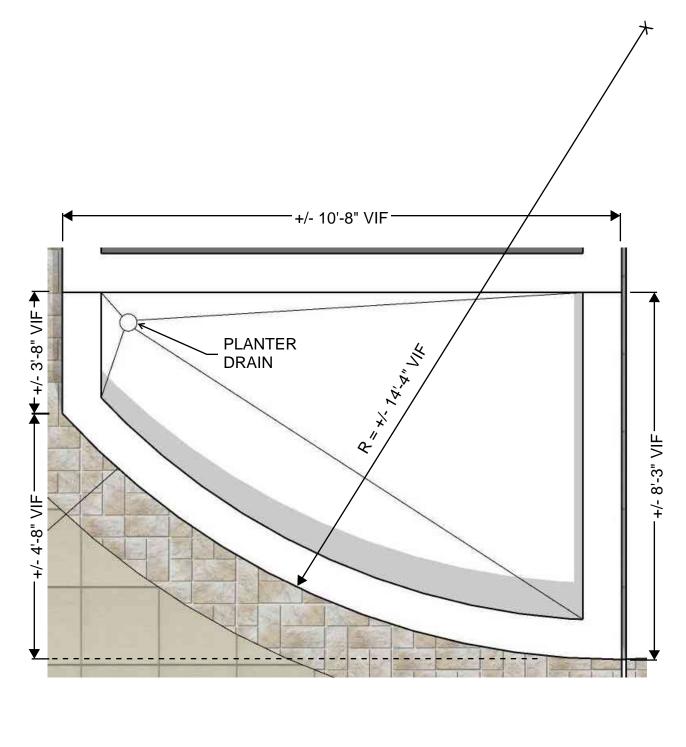





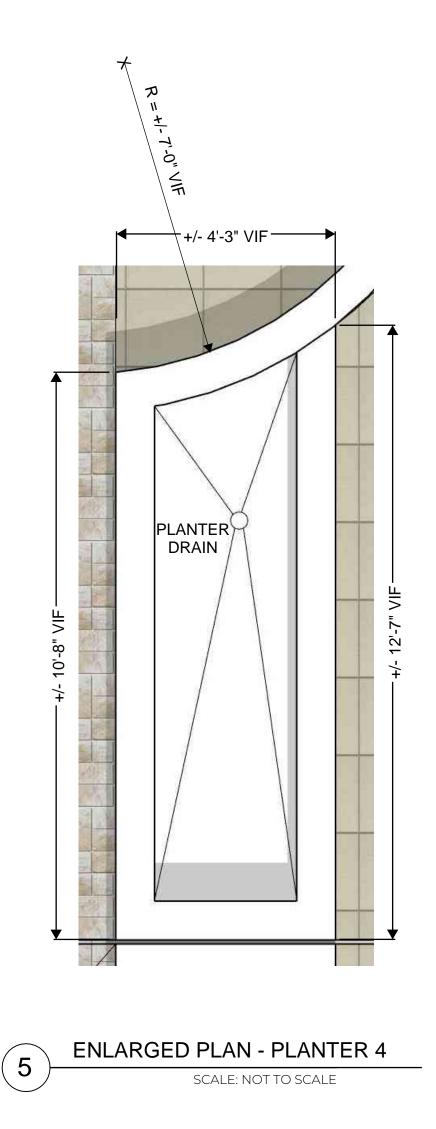

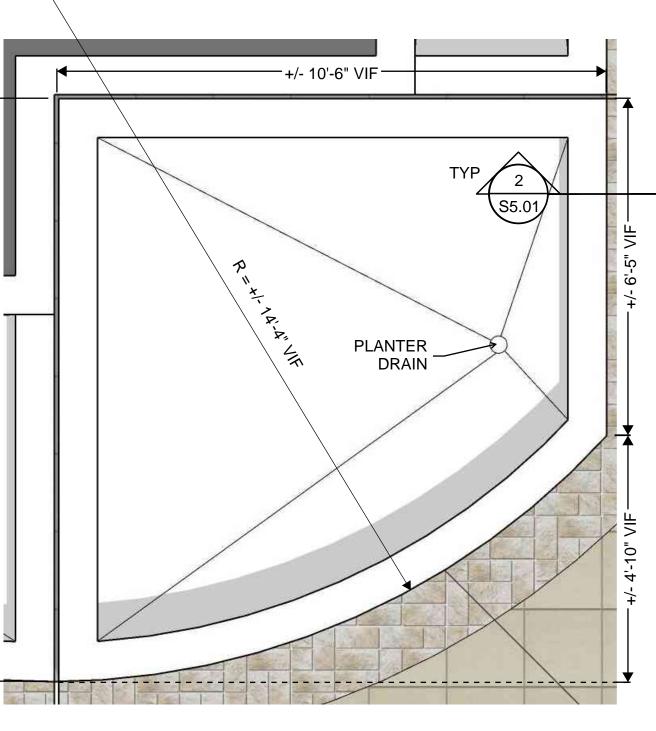



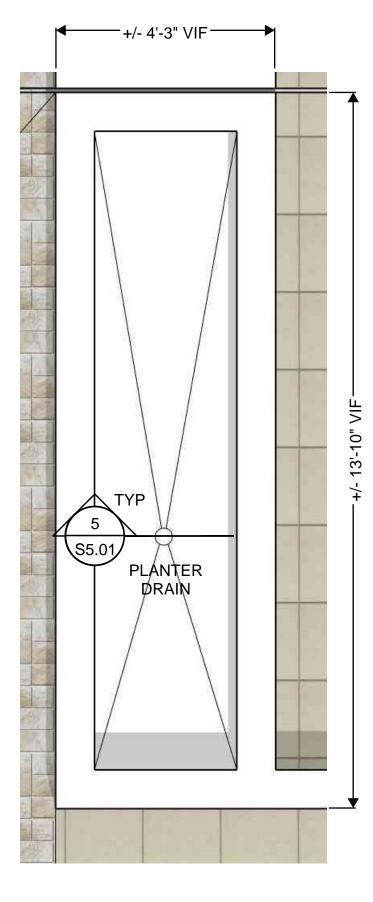

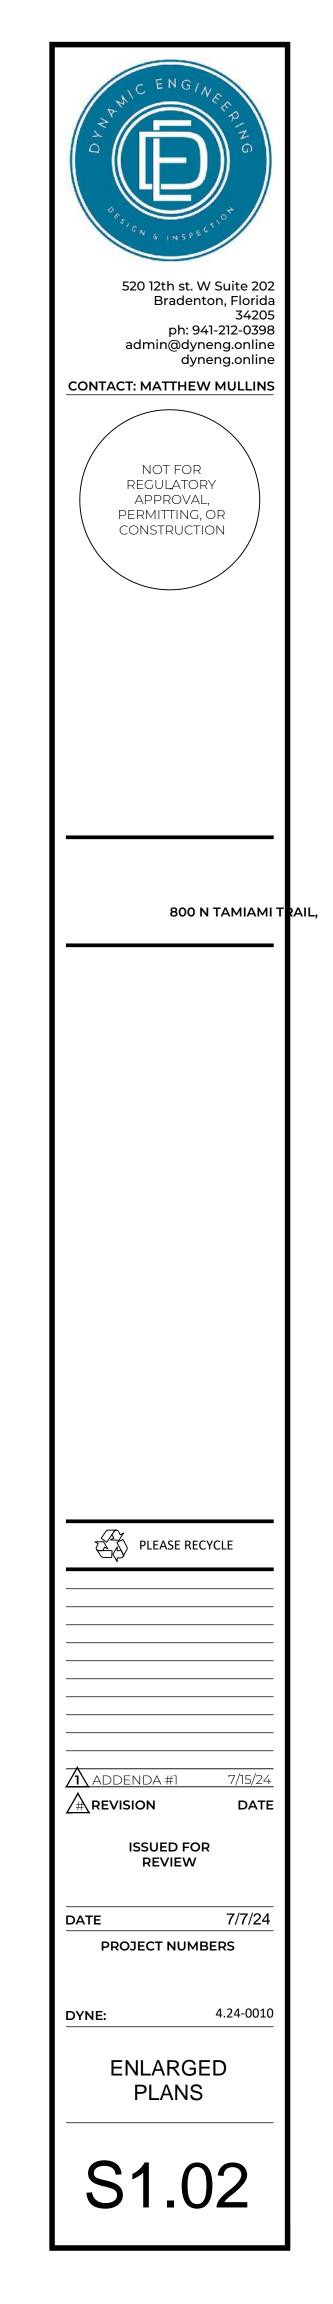

ENLARGED PLAN - PLANTER 5 SCALE: NOT TO SCALE

6

