
# CONDOMINIUM

800 N TAMIAMI TRAIL, SARASOTA, FL 34236



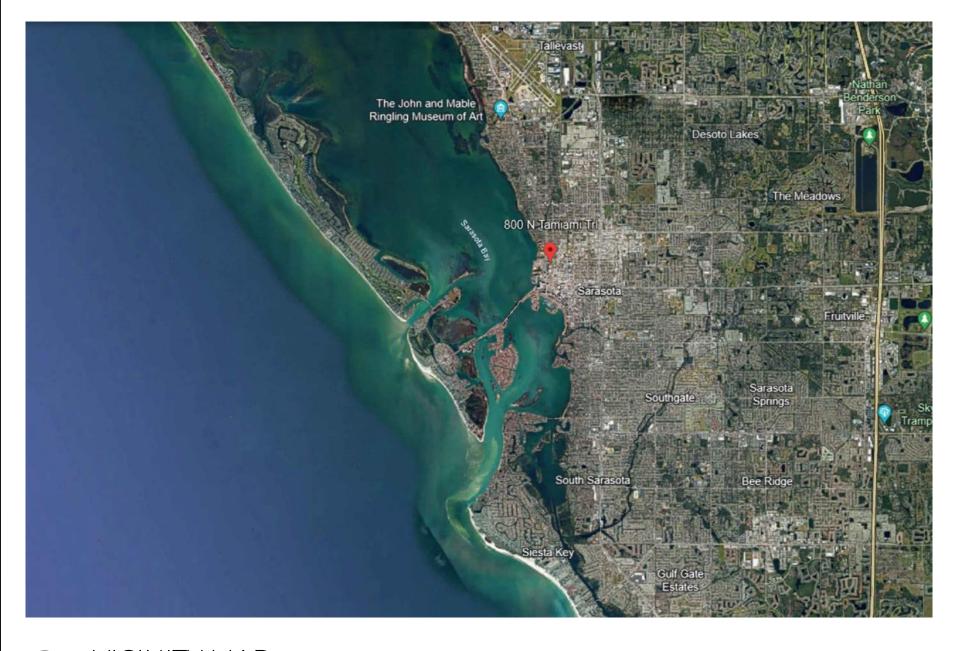

### VICINITY MAP

## ABBREVIATIONS


AB	AIR BARRIER
AD	AREA DRAIN
ADH	ADHESIVE
AHJ	AUTHORITY HAVING
	JURISDICTION
ALUM	ALUMINUM
ANC	ANCHOR, ANCHORED
ANOD	ANODIZED
APPROX	
ARCH	ARCHITECT,
/ (rterr	ARCHITECTURAL
ASPH	ASPHALT, ASPHALTIC
ASSY	ASSEMBLY
BD	BOARD
BIT	BITUMEN, BITUMINOUS
BLDG	
BLKG	BLOCKING
BM	BEAM
BRKT	BRACKET
BTM	BOTTOM
BTW	BETWEEN
CEM	CEMENT, CEMENTITIOUS
CEN	CENTER
CFL	COUNTERFLASHING
CFMF	COLD FORMED METAL
CLIM	FRAMING
CL	CENTER LINE
CMU	CONCRETE MASONRY
CIVIO	UNIT
CNTR	COUNTER
COL	COLUMN
CONC	CONCRETE
COND	CONDITION
CPR	COPPER
DIA	DIAMETER
DIA	DIMENSION
DRN	DRAIN
DRN DS	DOWNSPOUT
DTL	DETAIL
EIFS	EXTERIOR INSULATION
LII S	AND FINISH SYSTEM
EJ	EXPANSION JOINT
EQ	EQUAL
EQUIP	EQUIPMENT
ETR	EXISTING TO REMAIN
EXP	EXPANSION
EXST	EXISTING
EXT	EXTERIOR
FD	FLOOR DRAIN
	FIREBLOCKING
FLSHG	FLASHING
FNDN	FOUNDATION
FP	FIREPROOFED,
I F	FIREPROOFING
FRJ	FIRE RESISTIVE JOINT
FRM	FRAME, FRAMED,
1 1 1 1 1	FRAMING
FRT	FIRE RETARDANT
	TREATED
FSTN	FASTENER
FT	FOOT, FEET
GALV	GALVANIZED
HDR	HEADER
HOR	
	HEIGHT
JST	JOIST
MECH	MECHANICAL
MEMB	MEMBRANE
MEP	MECHANICAL,
	ELECTRICAL, AND
	PLUMBING
MFR	MANUFACTURER,
1.11.1.X	MANUFACTURED
MIFRC	MASTIC AND
	INTUMESCENT FIRE
	RESISTIVE COATING
MIN	MINIMUM
MIR	MIRROR
MISC	MISCELLANEOUS
MNRL	MINERAL
· · · · •	—

MOD	MODIFIED
	MOUNTED
MTL	METAL
N	NORTH
-	NOT IN CONTRACT
	NUMBER
NSMF	NON-STRUCTURAL METAL
NOIVIE	FRAMING
NTS	NOT TO SCALE
OC	ON CENTER
OD	OUTSIDE DIAMETER,
	OVERFLOW DRAIN
ЭН	OPPOSITE HAND
OPCI	OWNER PROVIDED,
	CONTRACTOR INSTALLED
OPOI	OWNER PROVIDED,
	OWNER INSTALLED
PERF	PERFORATED
ΣĽ	PLATE
PLAS	PLASTER
PLBG	PLUMBING
	PLYWOOD
PT	PRESSURE TREATED
- PTD	PAINTED
QTR	QUARTER
218 2	RISER
RAD	
	RADIUS
	ROOF DRAIN
	REFER, REFERENCE
REINF	REINFORCED
REQD	
RESIL	RESILIENT
REV	REVISION
RFG	ROOFING
RO	ROUGH OPENING
SAB	SOUND ATTENUATION
	BLANKET
SBR	SEALANT & BACKER ROD
SCHED	SCHEDULE, SCHEDULED
SFRM	SPRAY APPLIED
	FIRE-RESISTIVE MATERIAL
SHT	SHEET
SLNT	SEALANT
SS	STAINLESS STEEL
STL	STEEL
	STRUCTURAL
	SYSTEM
SYS	
T&G	TONGUE AND GROOVE
THRU	HROUGH
TME	TO MATCH EXISTING
TOC	TOP OF CONCRETE
TOST	TOP OF STEEL
TWF	THROUGH WALL
	FLASHING
JIO	UNLESS INDICATED
	OTHERWISE
JL	UNDERWRITERS
	LABORATORIES
JNDRLAY	UNDERLAYMENT
JNF	UNFINISHED
VB	VAPOR BARRIER
VERT	VERTICAL
	VERIFY IN FIELD
	VENEER
	WITH
	WITHOUT
	WALL BOARD
WD	WOOD
WNDW	WINDOW
WP	WORKPOINT,
	WATERPROOFING
WS	WATERSTOP
WTW	WALL-TO-WALL
	WELDED WIRE FABRIC
	WELDED WIRE MESH

## FLORIDA PRODUCT APPROVALS

### HENRY PUMADEQ - FL42468 HENRY PRODEQ - FL42469

### **CONDO ASSOCIATION**

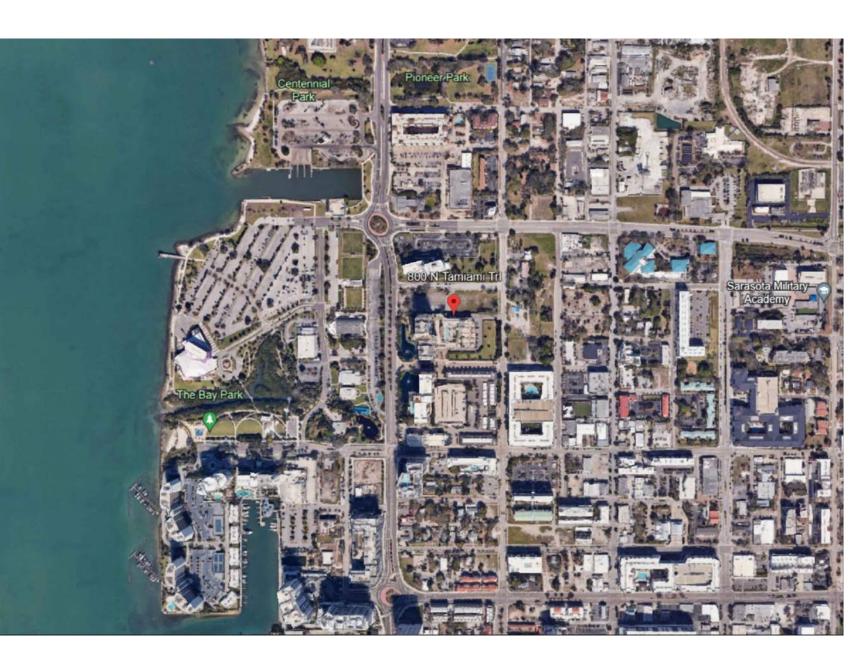

### PROJECT SITE MAP

## GENERAL NOTES


DRAWING INDEX G-0.01 S-1.01 COVER SHEET PLAN S-1.02 ENLARGED PLANS FRAMING PLANS & SECTIONS S-1.03 S-5.01 DETAILS S-5.02 DETAILS 520 12th st. W Suite 202 Bradenton, Florida 34205 ph: 941-212-0398 admin@dyneng.online dyneng.online CONTACT: MATTHEW MULLINS NOT FOR REGULATORY APPROVAL, PERMITTING, OR CONSTRUCTION MATERIALS CONCRETE WOOD BLOCK STEEL CONCRETE WALL BOARD PLASTER R-2 PLYWOOD CAVITY DRN 11 MATERIAL FING SYMBOLS ΖO ROOM NAME  $\equiv 0$ **ROOM NAME & NUMBER** OFFICE Σž 001 **REVISION REFERENCE - SEE** 0 d REVISION SCHEDULE IN TITLEBLOCK OF THE SHEET  $\Box \alpha$ /1\ 10/10/10 WHERE REFERENCE IS CONI INDICATED LEVEL 1 🔻 TOSL 100'-0" ELEVATION SYMBOL ♣ 100'-0" SPOT ELEVATION SYMBOL ELEVATION CHANGE SYMBOL "ו 🖵 EXTERIOR ELEVATION 1 \$1.01 REFERENCE BUILDING SECTION \\$5.01∕ REFERENCE PLEASE RECYCLE WALL SECTION REFERENCE \$5.01 1/S-5.01 DETAIL REFERENCE SPACING, AND CONNECTION TO EXISTING (SI.01) DETAIL REFERENCE MAP DRAWING TITLE - THE DRAWING NUMBER REFERS TO THE /ı∖ addenda #1 7/15/24 DRAWING, THE SCALE REFERS SCALE: N/A TO THE SCALE OF THE DATE PARTICULAR DRAWING ON THE SHEET ISSUED FOR INTERIOR ELEVATION REVIEW 4◀ S-1.01 ▶2 REFERENCE PHOTOGRAPH REFERENCE -7/7/24 X DATE INDICATES APPROXIMATE LOCATION AND DIRECTION  $\langle \gamma \rangle$ PROJECT NUMBERS OF REFERENCED PHOTOGRAPH DOOR REFERENCE 4.24-0010 DYNE: / 100 KEY NOTE REFERENCE - SEE KEY NOTES ON THE SHEET (1)COVER WHERE REFERENCE IS INDICATED SHEET A.1 EXISTING COLUMN GRID TAG (A.1) G0.01 NEW COLUMN GRID TAG <sup>–</sup> TRUE NORTH PLAN NORTH

- 2023 FBC BUILDING, 8TH ED.


WORK SHALL BE INSTALLED IN ACCORDANCE WITH THE APPROVED CONSTRUCTION

OCCUPANCY:

SECURE AND PAY FOR ALL PERMITS AND GOVERNMENTAL FEES, LICENSES AND INSPECTIONS NECESSARY FOR THE PROPER EXECUTION AND COMPLETION OF THE WORK. VERIFY ALL DIMENSIONS, EXISTING CONDITIONS, AND QUANTITIES PRIOR TO BEGINNING WORK. NOTIFY THE ENGINEER IMMEDIATELY UPON DISCOVERY OF ANY UNFORESEEN CONDITIONS. DO NOT SCALE DRAWINGS. OBTAIN OWNER APPROVAL FOR ALL COLORS AND FINISHES. CODES AND STANDARDS ALL WORK MUST BE PERFORMED IN ACCORDANCE WITH: • 2023 FBC - EXISTING BUILDING, 8TH ED. • 2023 FBC - PLUMBING, 8TH ED. ASCE/SEI 7-22 NRCA WATERPROOFING MANUAL SMACNA ARCHITECTURAL SHEET METAL MANUAL MANUFACTURER'S INSTALLATION INSTRUCTIONS APPLICABLE FLORIDA PRODUCT APPROVALS INDUSTRY STANDARDS, GUIDES AND BEST PRACTICES • FEDERAL, STATE AND LOCAL LAWS, RULES AND REGULATIONS AMENDED CONSTRUCTION DOCUMENTS DOCUMENTS, AND ANY CHANGES MADE DURING CONSTRUCTION THAT ARE NOT IN COMPLIANCE WITH THE APPROVED CONSTRUCTION DOCUMENTS SHALL BE RESUBMITTED FOR APPROVAL AS AN AMENDED SET OF CONSTRUCTION DOCUMENTS. BUILDING DATA CONSTRUCTION TYPE: MEANS OF EGRESS NO CHANGE IN MEANS OF EGRESS DEFERRED SUBMITTALS DEFERRAL OF ANY SUBMITTAL ITEMS SHALL HAVE THE PRIOR APPROVAL OF THE BUILDING OFFICIAL. THE REGISTERED DESIGN PROFESSIONAL IN RESPONSIBLE CHARGE SHALL LIST THE DEFERRED SUBMITTALS ON THE CONSTRUCTION DOCUMENTS FOR REVIEW BY THE BUILDING OFFICIAL. DOCUMENTS FOR DEFERRED SUBMITTAL ITEMS SHALL BE SUBMITTED TO THE REGISTERED DESIGN PROFESSIONAL IN RESPONSIBLE CHARGE WHO SHALL REVIEW THEM AND FORWARD THEM TO THE BUILDING OFFICIAL WITH A NOTATION INDICATING THAT THE DEFERRED SUBMITTAL DOCUMENTS HAVE BEEN REVIEWED AND FOUND TO BE IN GENERAL CONFORMANCE TO THE DESIGN OF THE BUILDING. THE DEFERRED SUBMITTAL ITEMS SHALL NOT BE INSTALLED UNTIL THE DEFERRED SUBMITTAL DOCUMENTS HAVE BEEN APPROVED BY THE BUILDING OFFICIAL. LIST OF DEFERRED SUBMTTALS: • PLUMBING PLAN - SHOW DRAIN LOCATION, DRAIN LEADER SIZE AND SLOPE, HANGER ENGINEER'S STATEMENT TO THE BEST OF THE ENGINEER'S KNOWLEDGE, JUDGMENT AND BELIEF, THESE DRAWINGS WERE PREPARED TO COMPLY WITH THE REQUIREMENTS OF THE FOLLOWING STANDARDS AND CODES: 2023 FBC - BUILDING, 8TH ED. 2023 FBC - EXISTING BUILDING, 8TH ED. 2023 FBC - PLUMBING, 8TH ED. THESE DRAWINGS ARE NOT VALID: IF A NEW VERSION OF THE CODE IS ADOPTED BY THE AHJ PRIOR TO PERMITTING; AFTER ONE YEAR; UNLESS SIGNED BY A LICENSED PROFESSIONAL ENGINEER. THESE DRAWINGS SHALL BE VIEWED ON ARCH D (24 X 36) SHEETS. OTHER SHEETS ARE NOT VALID. © DYNAMIC ENGINEERING DESIGN & INSPECTION

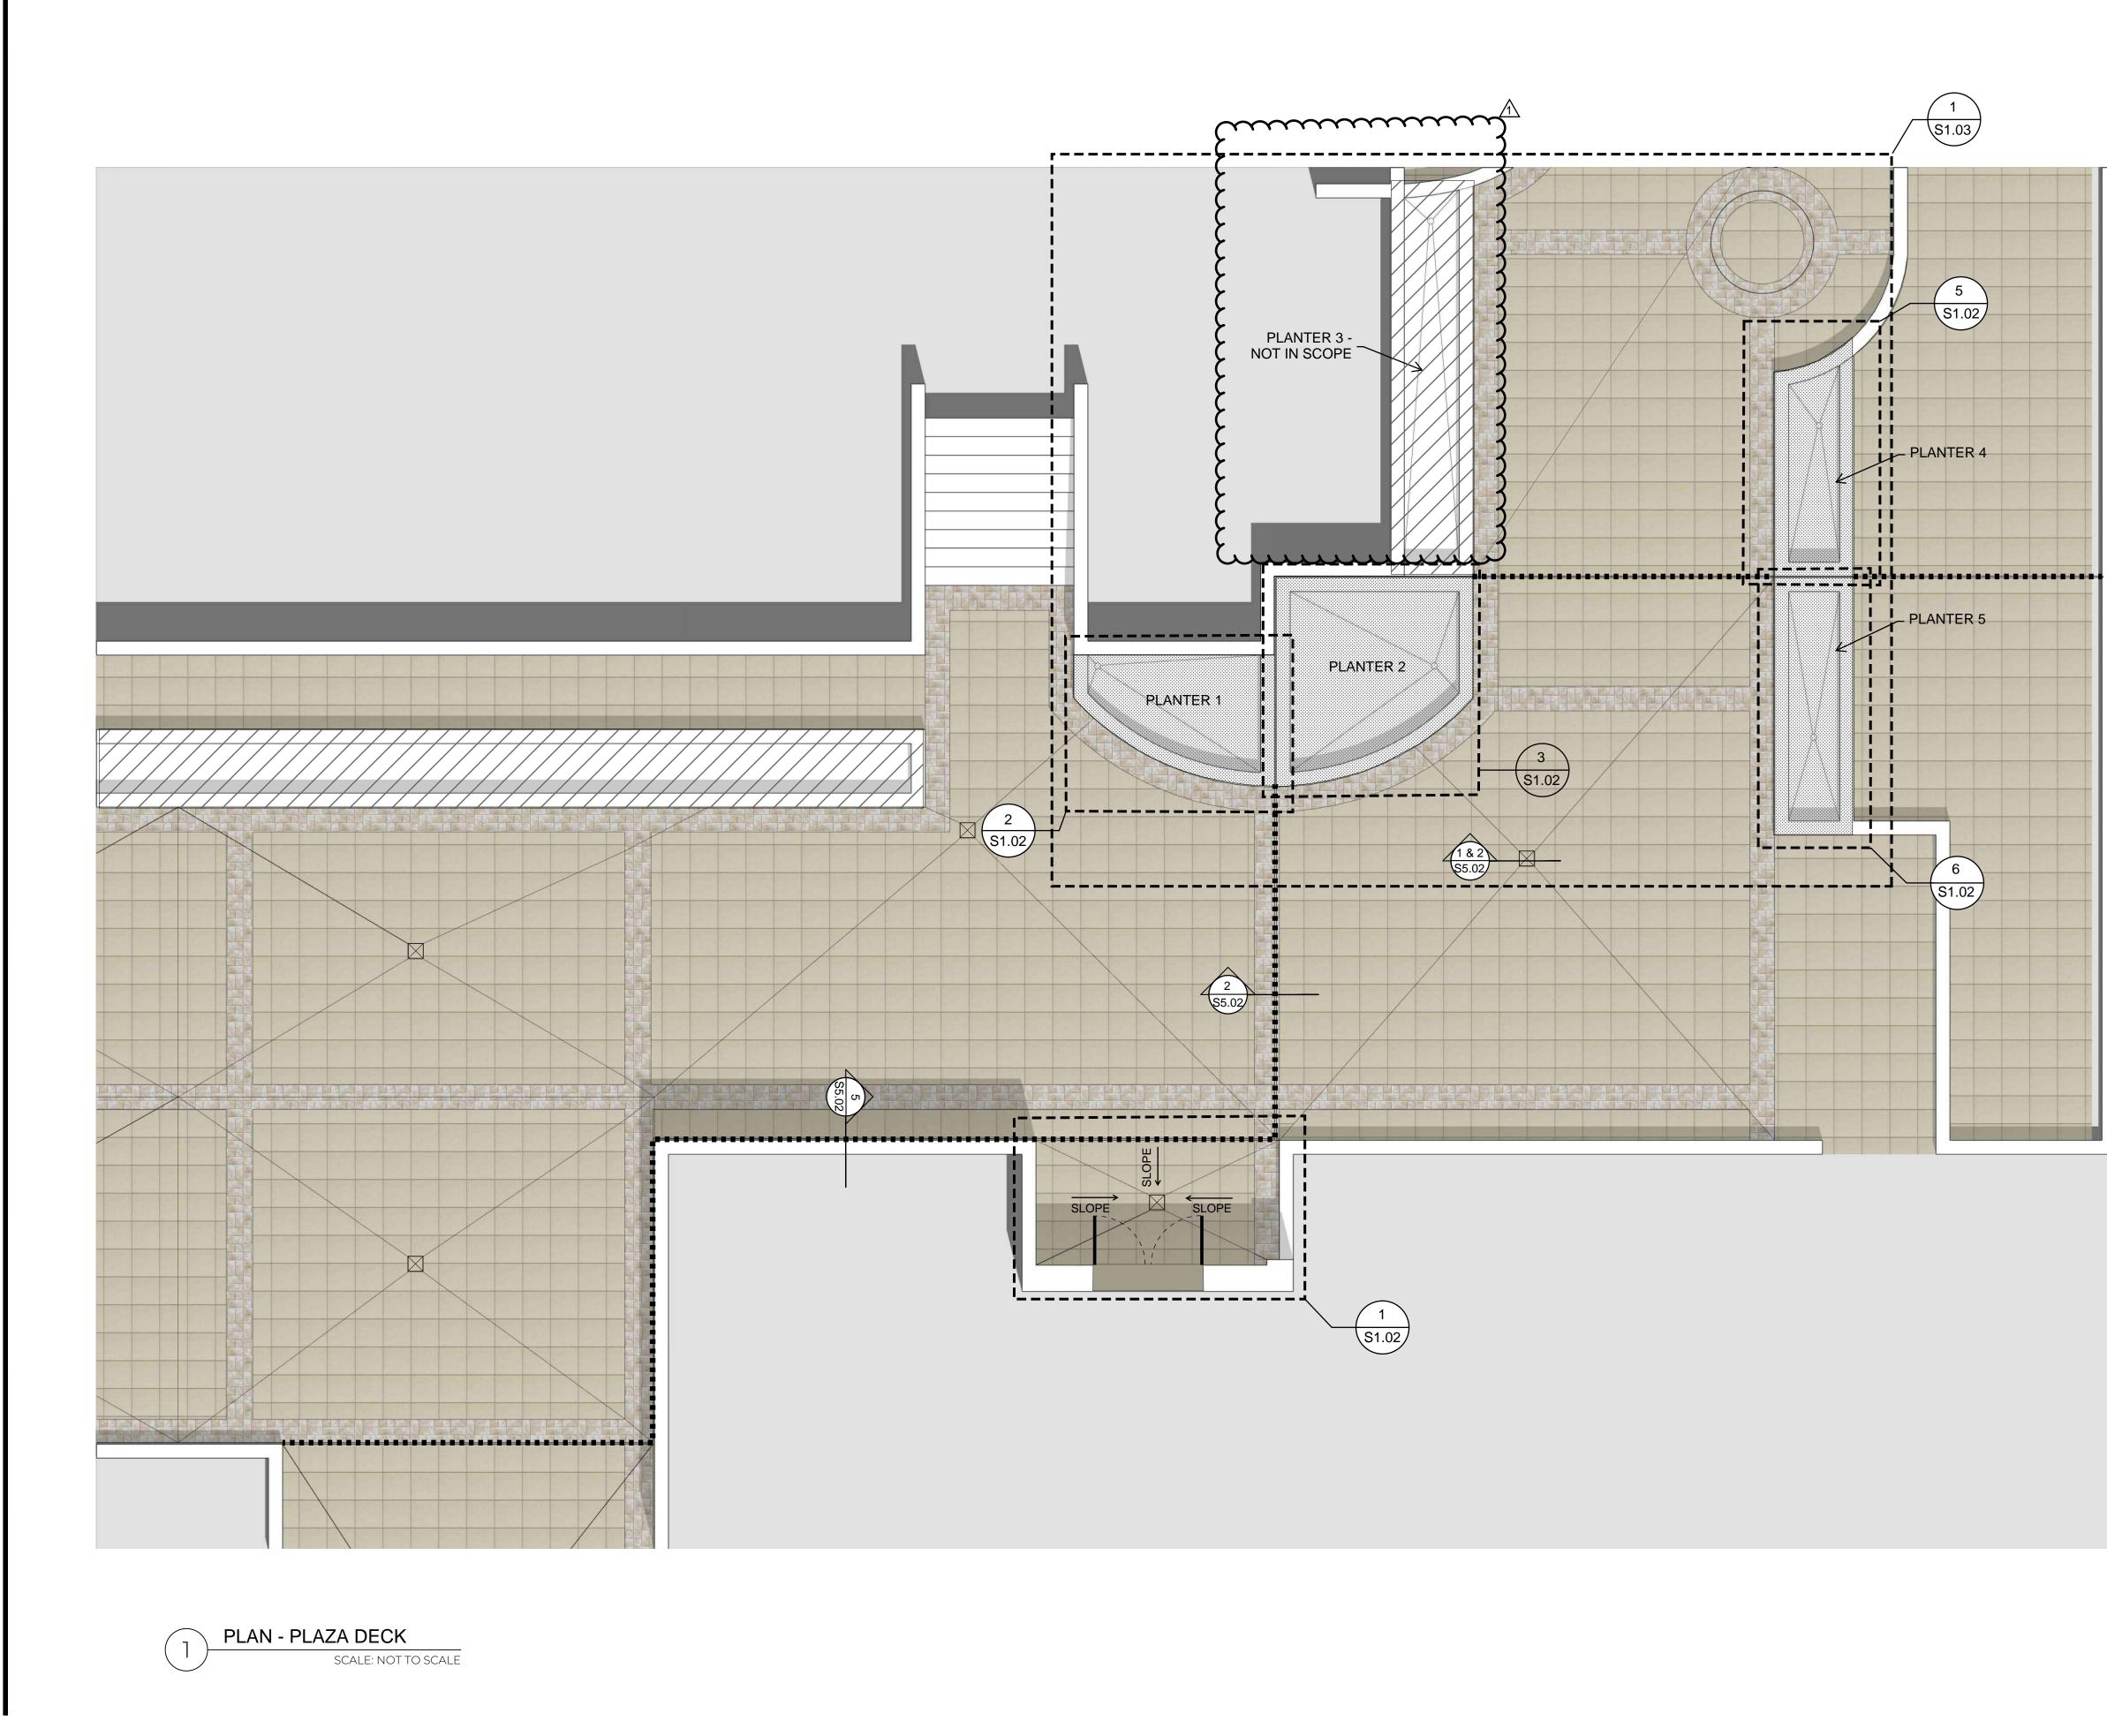


MIC ENGINEERING 2023 E:\07 FREELANCE WORK\ALINARI\ALINARI\ALINARI WATERPROOFING.DWG 6/14/2024 6:42:33

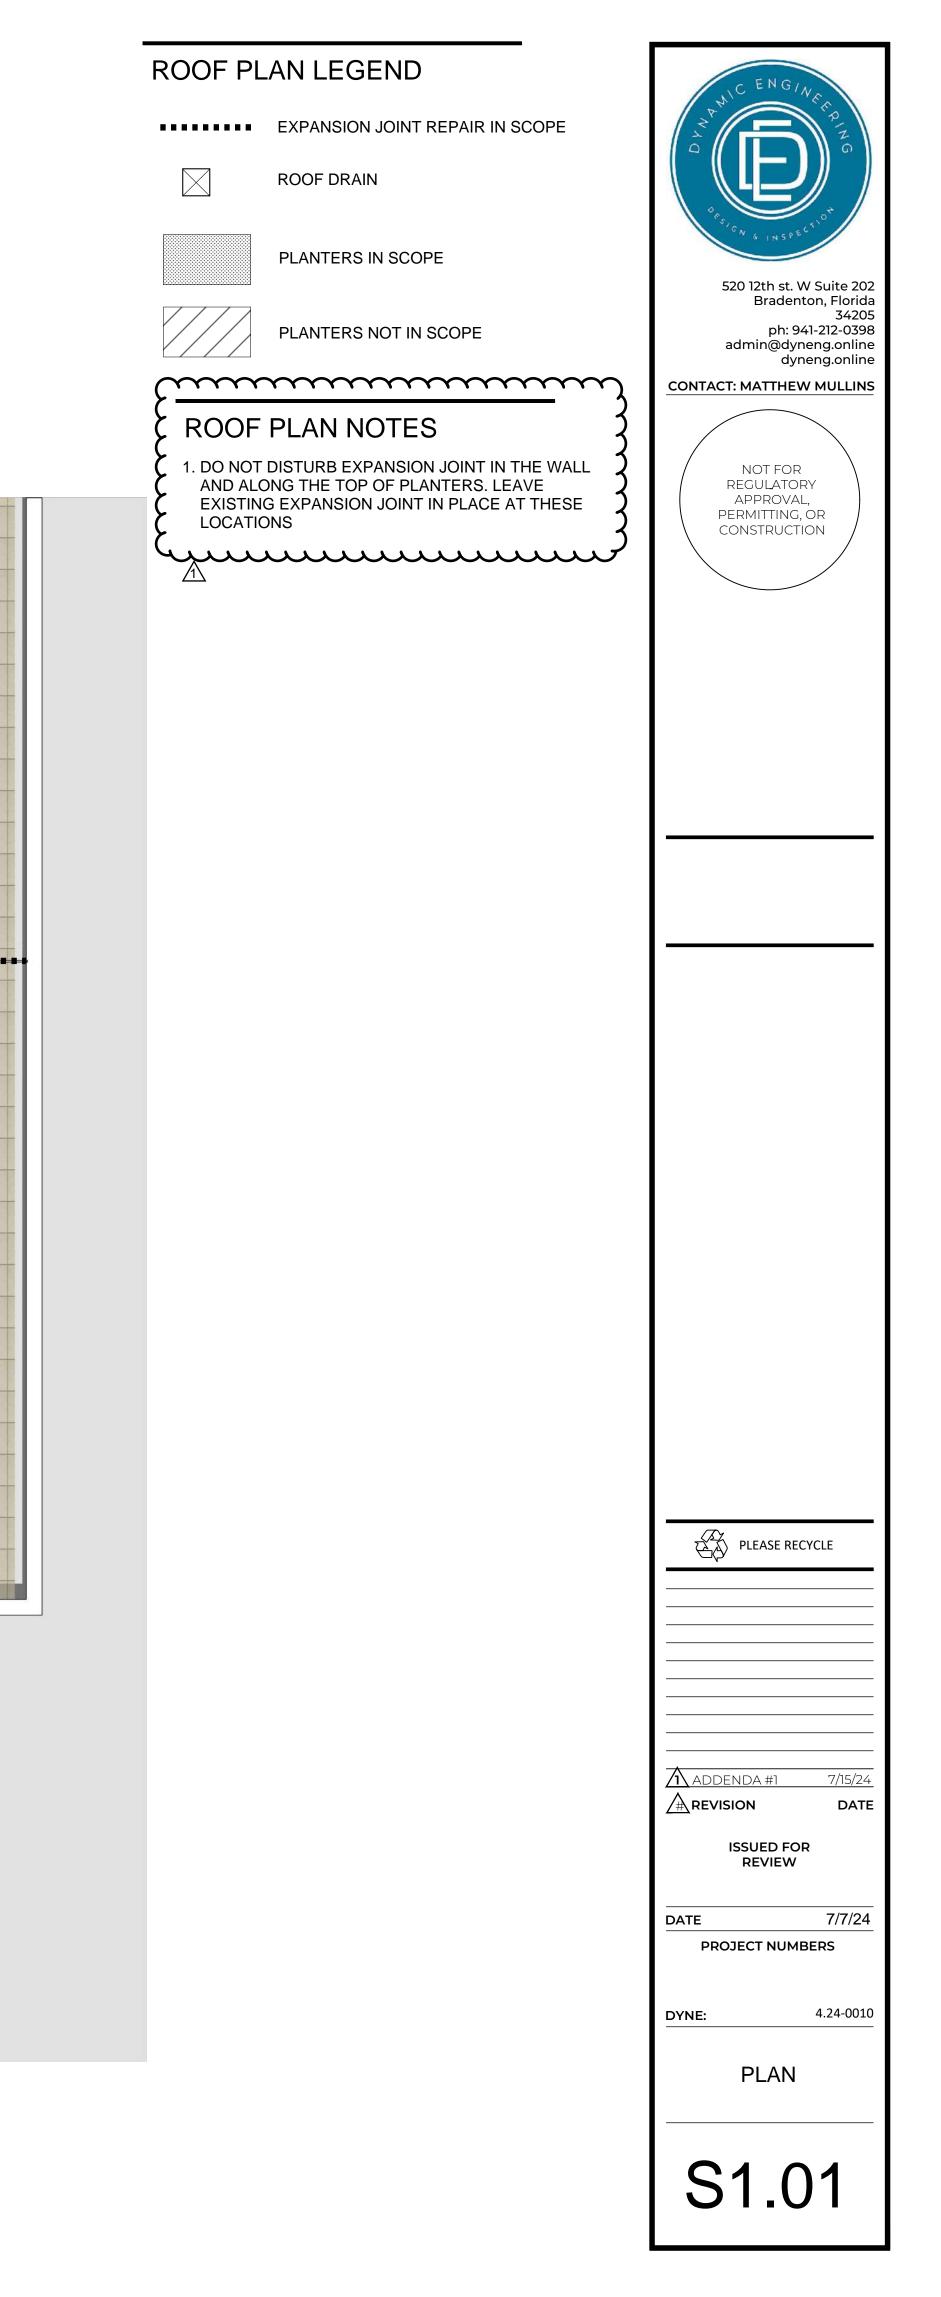


PROVIDE NEW DRAIN BOARD, TOPPING - SLAB AND BEDDING SAND BEFORE REINSTALLING EXISTING PAVERS


REMOVE ALL EXISTING MATERIAL, INSTALL NEW HENRY PUMADEQ FLEX SL WATERPROOFING OVER EXISTING - RUBBERIZED ASPHALT WATERPROOFING. INSTALL NEW DRAIN & DRAIN COMPONENTS TO MATCH EXISTING. REF 4/S5.02 FOR NEW ASSEMBLY

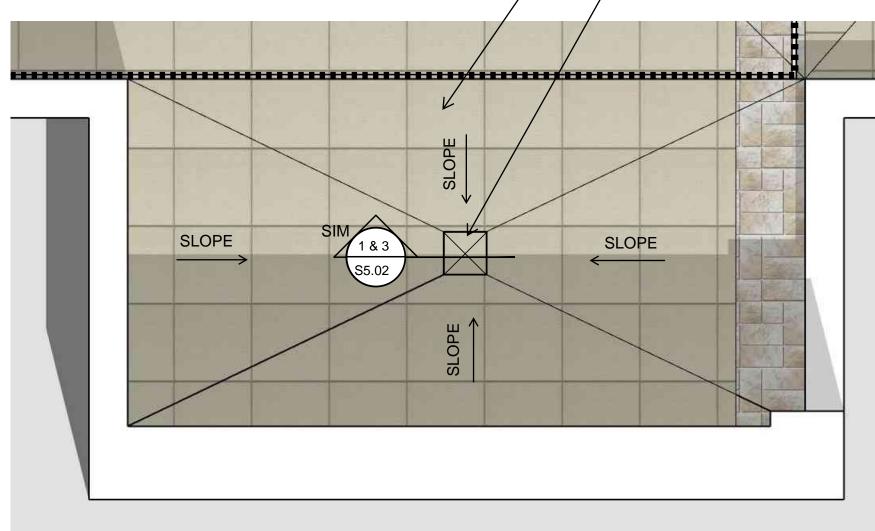


ENLARGED PLAN - NEW PLAZA DECK DRAIN 1 SCALE: NOT TO SCALE


FL 3436

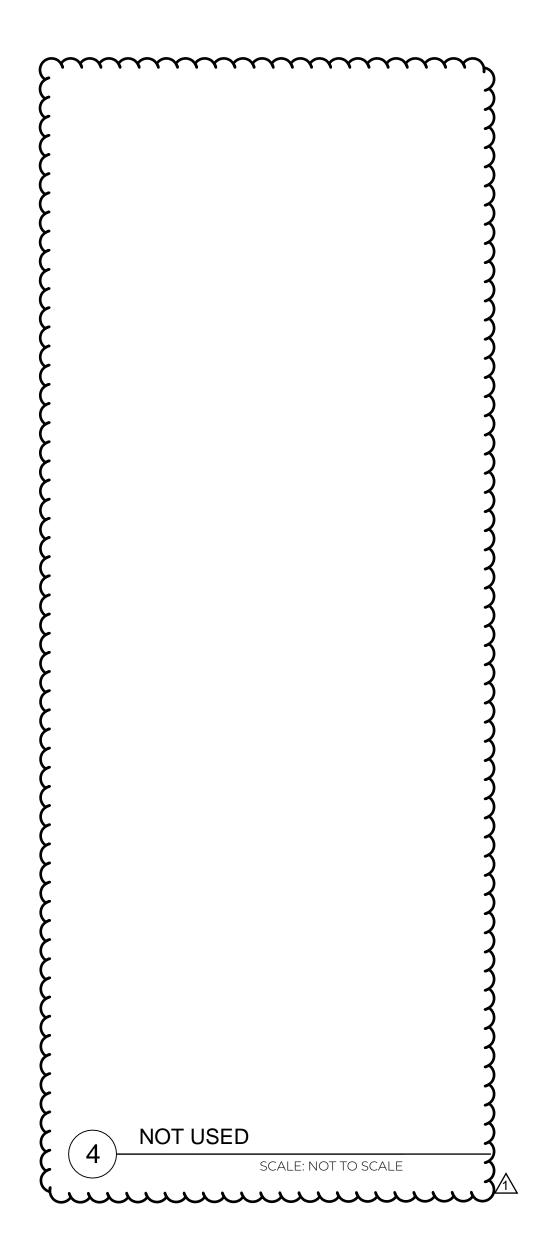

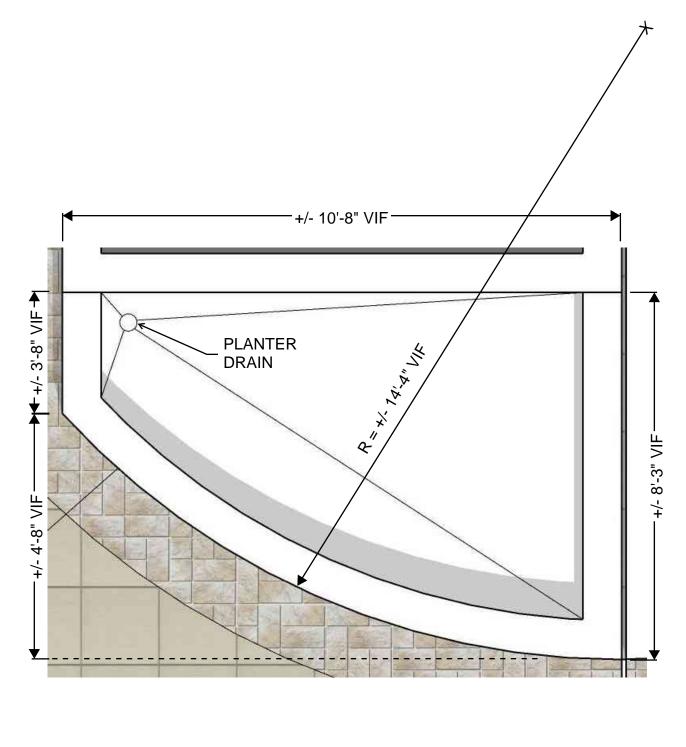





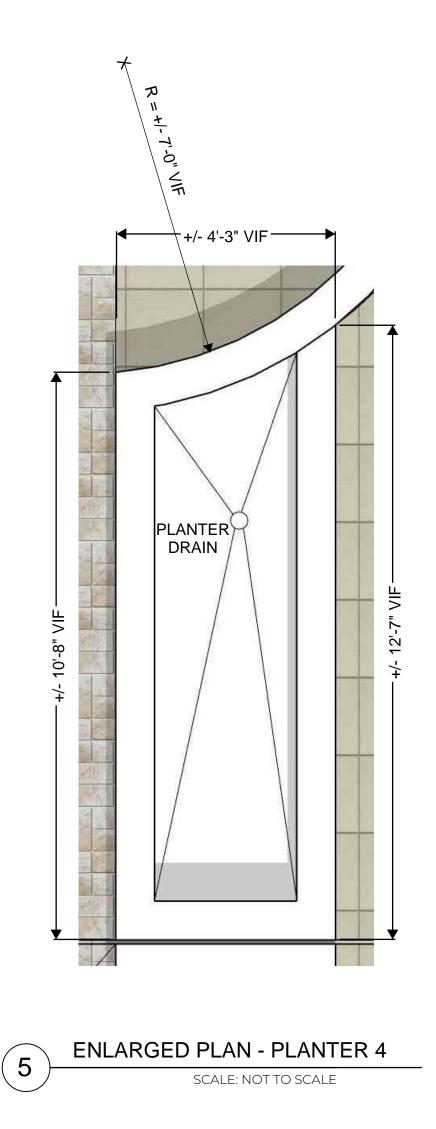

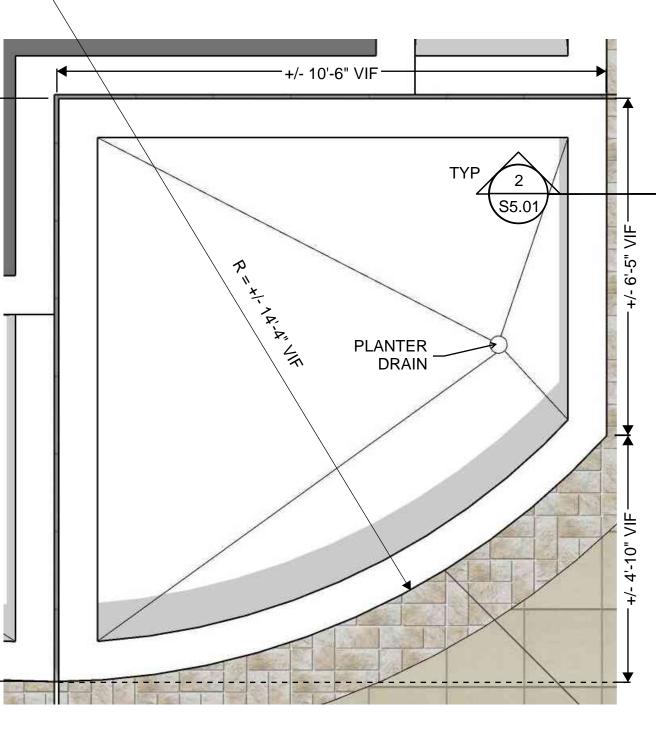



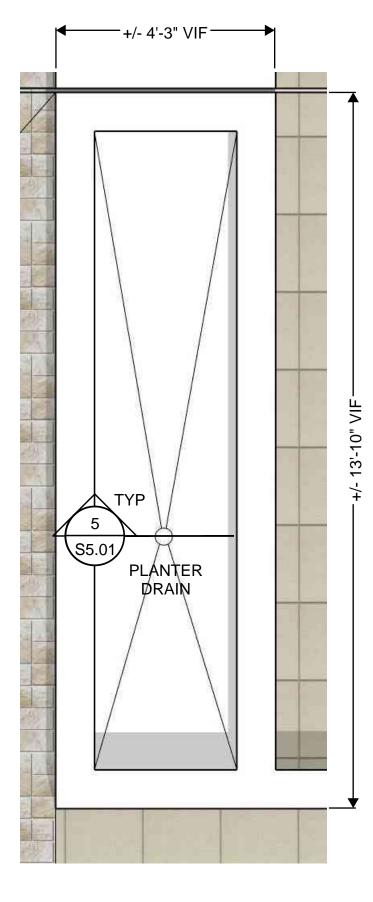

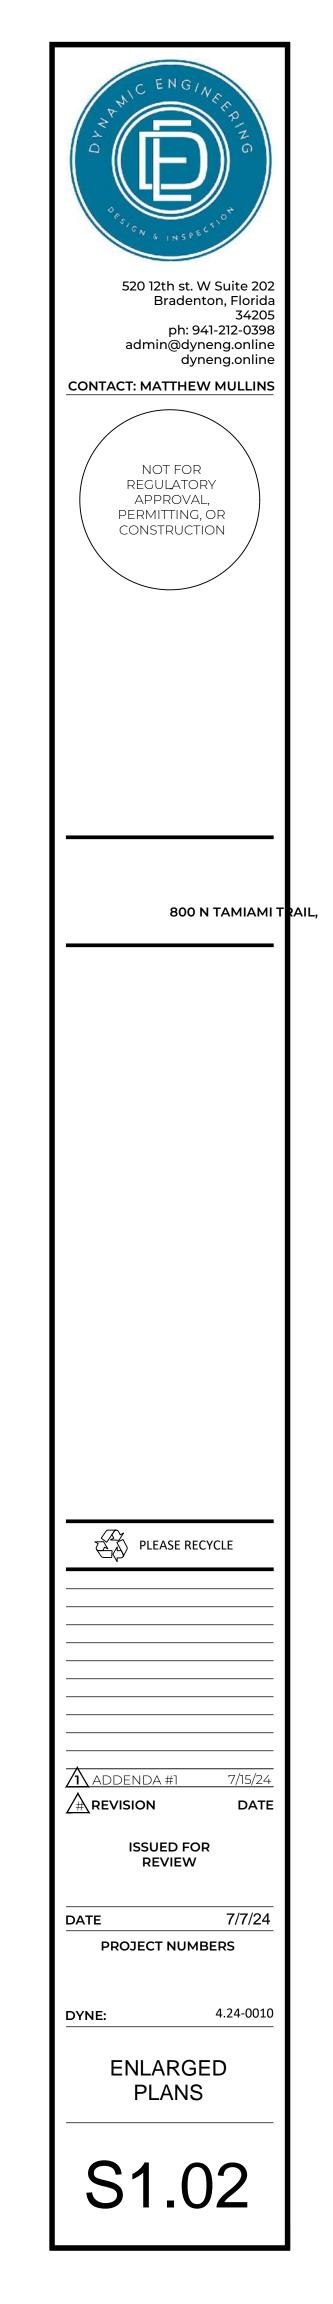

ENLARGED PLAN - PLANTER 5 SCALE: NOT TO SCALE

6

